


GARAGE BUILDING ATTIC

SCALE: 3/16" = 1'-0"

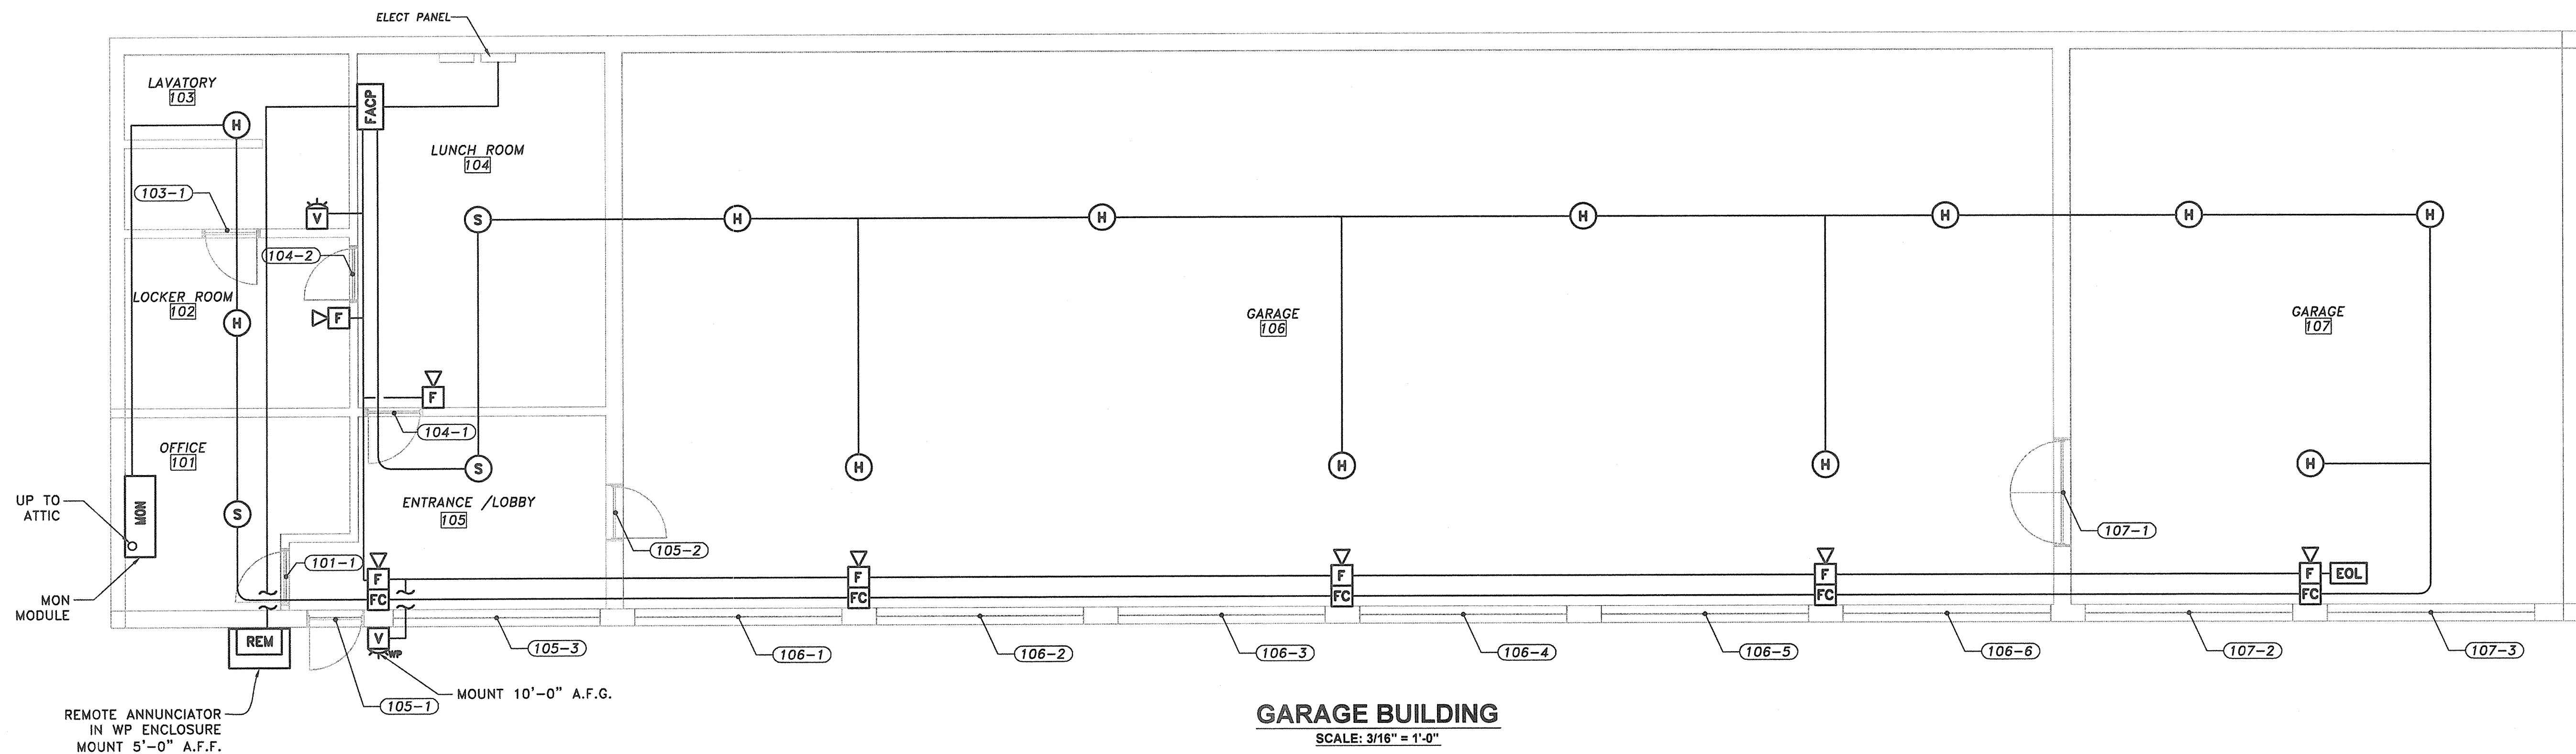

GARAGE BUILDING


SCALE: 3/16" = 1'-0"

FIRE ALARM INSTALLATION NOTES:

1. WIRING IN UNFINISHED SPACES TO BE INSTALLED IN ELECTRICAL METALLIC TUBING (EMT).
2. WIRING ABOVE DROP CEILINGS TO BE INSTALLED IN EMT.
3. CONDUCTORS TO BE AS RECOMMENDED BY EQUIPMENT MANUFACTURER.
4. CONTRACTOR TO SUBMIT VOLTAGE DROP CALCULATIONS FOR ALL CONDUCTOR RUNS.
5. PROVIDE SEPARATE RACEWAYS FOR NOTIFICATION AND SIGNAL WIRING.
6. DEMOLISH EXISTING FIRE ALARM SYSTEM AFTER COMMISSIONING NEW SYSTEM.
7. SEE SHEET FA-100 FOR EQUIPMENT LEGEND.

APPROVED:
Richard A. Alaimo
PROFESSIONAL ENGINEER
NEW JERSEY LICENSE NO. 13195

REVISIONS	DATE	BY

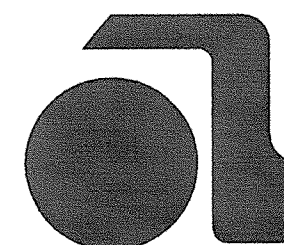

ALAIMO GROUP

Consulting Engineers
NJDC# 24GA27988400

200 HIGH STREET
2 MARKET STREET
MOUNT HOLLY, N.J.
PATERSON, N.J.

FIRE PROTECTION IMPROVEMENTS
VARIOUS PARK MAINTENANCE BUILDINGS
**RAHWAY RIVER PARK
MAINTENANCE GARAGE
DEVICE LOCATION PLAN**

SCALE: AS SHOWN

CLIENT:
COUNTY OF UNION

PROJECT LOCATION:
RAHWAY, SCOTCH PLAINS,
PLAINFIELD
UNION COUNTY
NEW JERSEY

RAA PROJECT NO.:
A-0530-0017-003
PROJECT NO.:
2010-026

DATE:
APR. 2013
DESIGNED BY:
SDR/PPM
DRAWN BY:
SDR/PPM
CHECKED BY:
SDR/PPM
DATE:
APR. 2013

SHEET

FA-103

FILE NO.: