


MAINTENANCE GARAGE
SCALE: 3/16" = 1'-0"

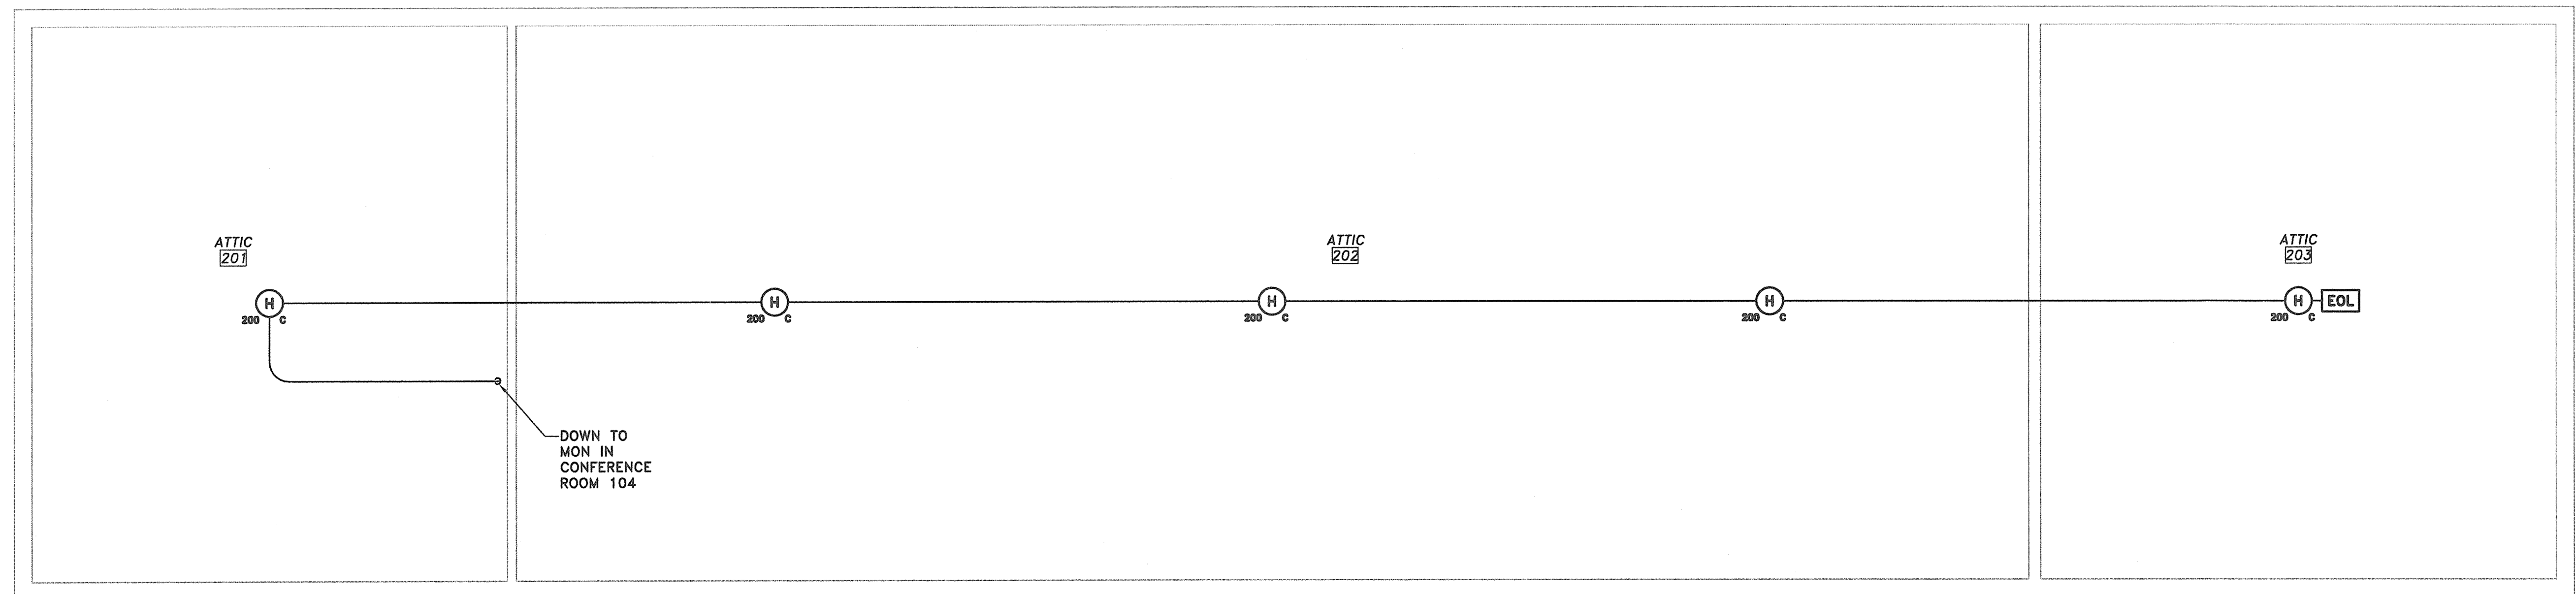

MAINTENANCE GARAGE ATTIC
SCALE: 3/16" = 1'-0"

FIRE ALARM INSTALLATION NOTES:

1. EXPOSED WIRING IN UNFINISHED SPACES TO BE INSTALLED IN ELECTRICAL METALLIC TUBING (EMT).
2. WIRING ABOVE DROP CEILINGS TO BE INSTALLED IN EMT.
3. CONDUCTORS TO BE AS RECOMMENDED BY EQUIPMENT MANUFACTURER.
4. CONTRACTOR TO SUBMIT VOLTAGE DROP CALCULATIONS FOR ALL CONDUCTOR RUNS.
5. PROVIDE SEPARATE RACEWAYS FOR NOTIFICATION AND SIGNAL WIRING.
6. DEMOLISH EXISTING FIRE ALARM SYSTEM AFTER COMMISSIONING NEW SYSTEM.
7. SEE SHEET FA-100 FOR EQUIPMENT LEGEND.

APPROVED:
Richard A. Alaimo
PROFESSIONAL ENGINEER
NEW JERSEY LICENSE NO. 13195

REVISIONS	DATE	BY

ALAIMO GROUP
Consulting Engineers
NJDCA 24GA27988400
200 HIGH STREET
2 MARKET STREET
MOUNT HOLLY, N.J.
PATERSON, N.J.

FIRE PROTECTION IMPROVEMENTS
VARIOUS PARK MAINTENANCE BUILDINGS
CEDAR BROOK PARK
MAINTENANCE GARAGE
DEVICE LOCATION PLAN
SCALE: AS SHOWN

CLIENT: COUNTY OF UNION	DATE: APR. 2013	SHEET FA-301
PROJECT LOCATION: RAHWAY, SCOTCH PLAINS, PLAINFIELD UNION COUNTY NEW JERSEY	RAA PROJECT NO.: A-0530-0017-003 PROJECT NO.: 2010-026	DESIGNED BY: SDR/PHM DRAWN BY: SDR/PHM CHECKED BY: SDR/PHM FILE NO.: